CURRENT REVISION + NOTES

Date: Description: 06.05.25 BATHROOM UPDATE/DECK NOTES

Issue: Di

ALTERATIONS & ADDITIONS

CLIENT: BROOKHOUSE

STATUS: DA ISSUE

LOT No: 88 **DP No:** 811825

STREET: 20 CARRABEEN DRIVE, OLD BAR 2430

CWC JOB #: A6058

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GENERIC | TYPICAL KEY, LEGEND AND ABBREVIATIONS FOR COLLINS W COLLINS ARCHITECTURAL PLANS


THESE NOTES MUST BE READ AND UNDERSTOOD BY ALL INVOLVED IN THE PROJECT. THIS INCLUDES (but is not limited to): OWNER, BUILDER, SUB-CONTRACTORS, CONSULTANTS, RENOVATORS, OPERATORS, MAINTAINERS, DEMOLISHERS. PLEASE USE THIS IN CONJUNCTION WITH ALL DRAWING SHEETS AND VIEWS CONTAINED FORTHWITH IN THIS PLAN SET.

REVISED IANUIARY 2021

SYMBOLS AND LINES

F.S.L

FINISHED SURFACE LEVEL

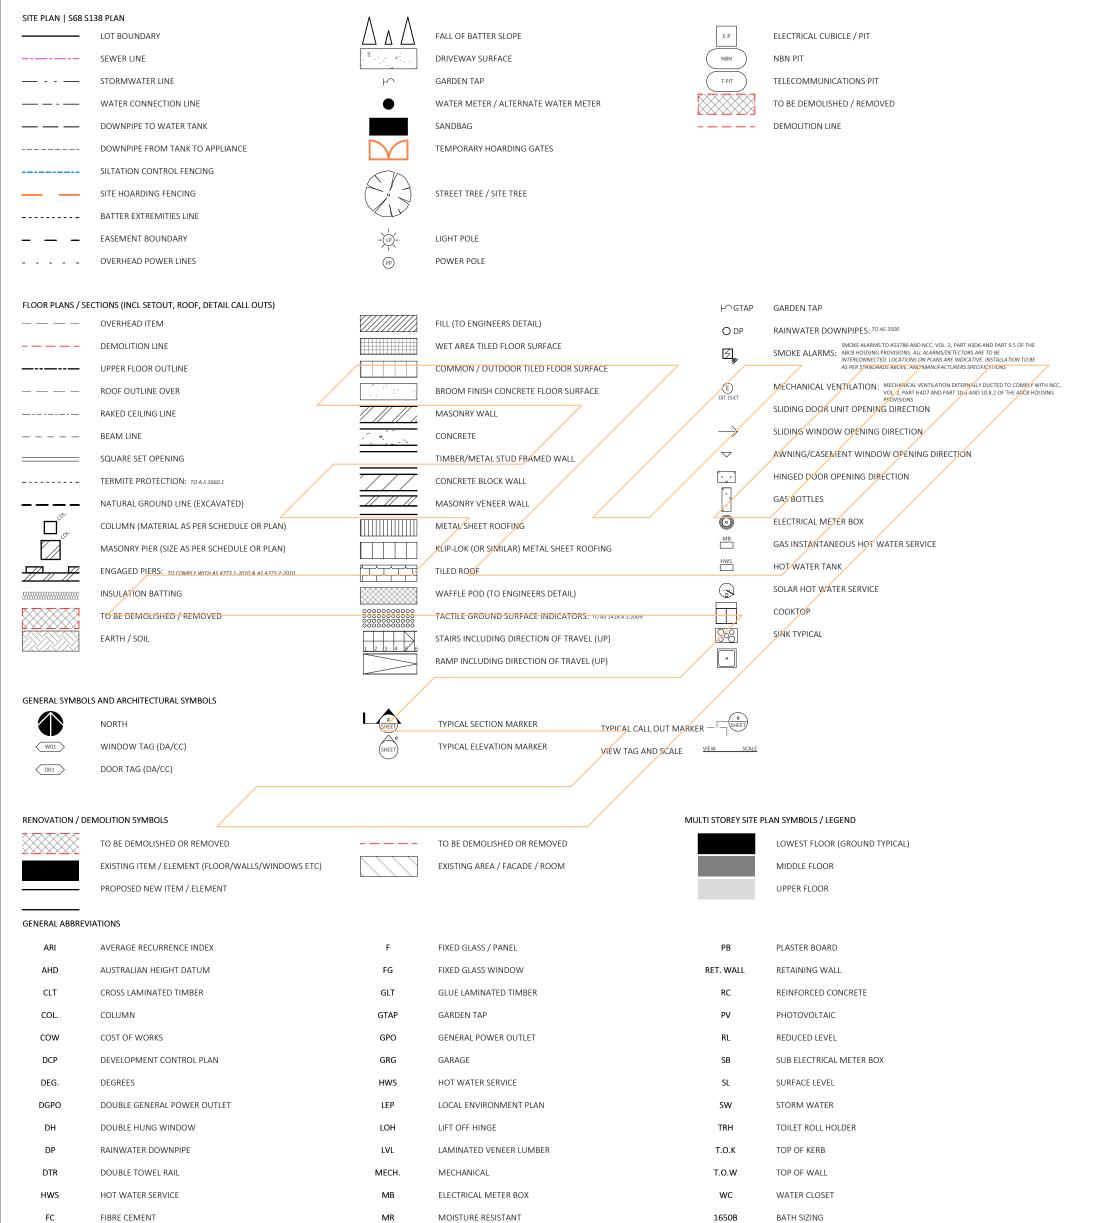

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	electronic, mechanical, photocopying, recording or otherwise, without the prior permission of the	STATUS: DA ISSUE	SHEET: 1 OF 18	SCALE:	1:100	17.02.25	REVISED	E	AE
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collinswcollins	DO NOT SCALE from this drawing. CONTRACTOR is to check all the dimensions on the job prior to	STREET: 20 CARRABEEN DRIVE, OLD	BAR 2430	SHEET SIZE:	A3	24.02.25	REVISED	G	AE
	commencement of snop drawings or fabrication.	JINEET. 20 CAMMADEEN DAIVE, OLD	D/ (11 Z + 30	START DATE:	03.12.2024		CC PLANS	Н	MS
Building Designers	Discrepancies to be referred to the consultant Designer prior to commencement of work.	CLIENT: BROOKHOUSE		DWG No:	4.6050	28.04.25	PLAN RFI/ENERGY	J	MS
	Designer prior to commencement of work.	CLILINI. BROOKHOUSE		DWG NO.	A6058	06.05.25	BATHROOM UPDATE/DECK NOTES	K	MS
89A Lord Street (PO Box 5667), Port Macquarie nsw 2444 Shop 17 Centrepoint Arcade, Taree NSW 2430		T: 02 6583 4411			WWW. COLLINSWO	COLLINS.	.COM.AU		

900V

820

VANITY SIZING


INTERIOR DOOR SIZING

МН


NGL

MAN HOLE

NATURAL GROUND LINE

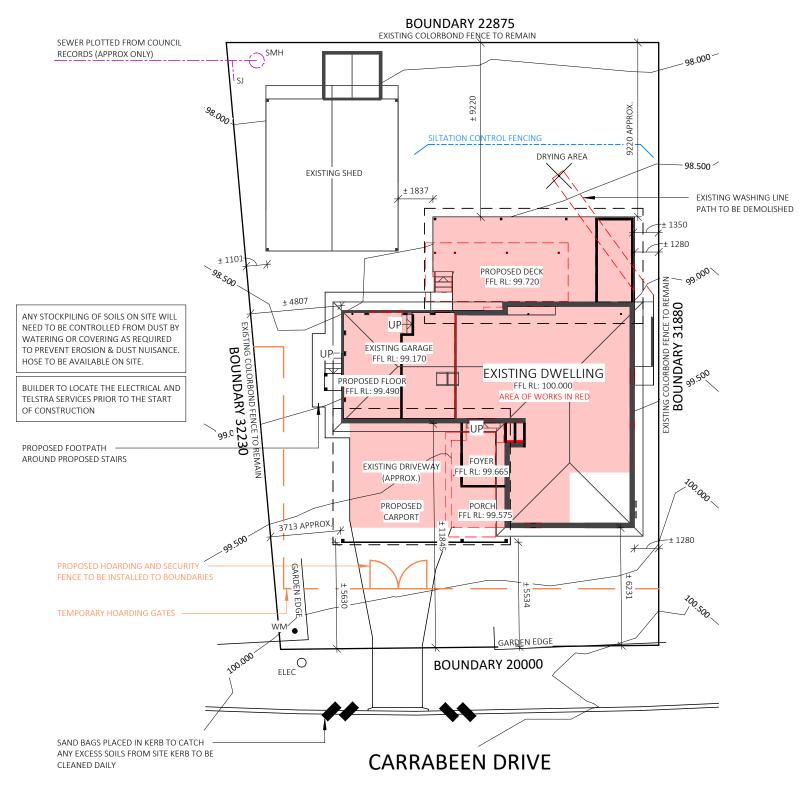



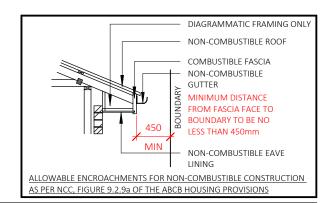

SITE INFORMATION & SILTATION CONTROL IN ACCORDANCE WITH COUNCIL LINE OF EASEMENTS **LEGEND** POLICY E1 AND THE ADOPTED AUSPEC STANDARD PROPOSED GARDEN TAP LOCATIONS SITE AREA: = 686m2 (APPROX..) GTAP ├^ SITE HOARDING AND SECURITY FENCE (TO BE USED AS A GUIDE ONLY) OVERALL HABITABLE AREA $= 150.1 m^2$ (including garages/store) LINE OF BATTER TO GROUND LEVELS $\triangle \land \triangle \land \triangle$ GROSS FLOOR AREA = 120.8 m²WATER MAINS (APPROX ONLY) (TO BE USED AS A GUIDE ONLY) (as per LEP definition) FLOOR SPACE RATIO = 18%; 0.18:1 ALL LEVELS ARE TO INDICATIVE AND NOT TO AHD. ALL LEVELS AND STORMWATER LINES (APPROX ONLY) CONTOURS ARE TO BE CONFIRMED BY BUILDER / SURVEYOR PRIOR TO **BUSHFIRE AFFECTED** YFS FLOOD AFFECTED NO START OF CONSTRUCTION. APPROX HARDSTAND AREA $= 334m^{2}$

BUSHFIRE NOTES:

BAL - 12.5

APPROX LANDSCAPED AREA

PLEASE REFER TO BUSHFIRE SELF ASSESSMENT KIT BY CLIENT/OWNER & TO BE CONSTRUCTED IN ACCORDANCE WITH AS 3959-2018: CONSTRUCTION OF BUILDINGS IN BUSHFIRE PRONE AREAS

 $= 352m^2$

BASIX NOTES:

SEWER LINES (APPROX ONLY)

PLEASE REFER TO THE "SUMMARY OF BASIX COMMITMENTS" ON PAGE 3 FOR FURTHER INFORMATION. PLEASE REFER TO THE BASIX CERTIFICATE FOR EXACT DETAILS

SITE PLAN

GENERAL PLAN SET NOTES:

CHECK ALL DIMENSIONS ON SITE. THIS DRAWING IS TO BE READ IN CONJUNCTION WITH ALL RELEVANT CONTRACTS, SPECIFICATIONS, REPORTS, DRAWINGS, LEGENDS, NATIONAL CONSTRUCTION CODE, AUS & NZ STANDARDS, ENGINEERING & COUNCIL APPROVALS

DRAWING REVISION + NOTES

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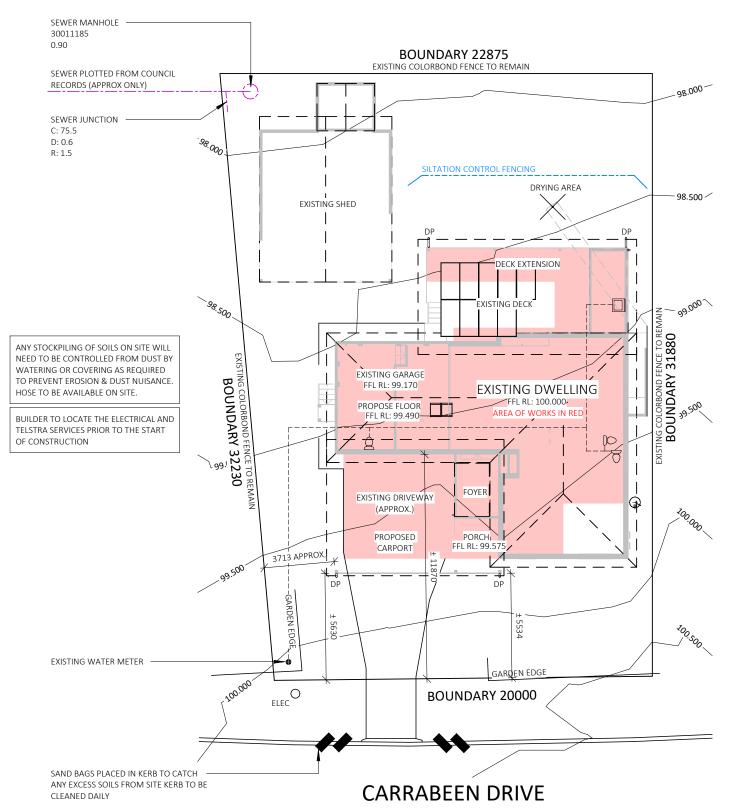
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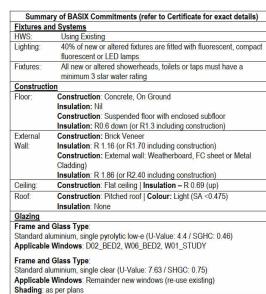
Designer prior to commencement of work.

PROJECT: ALTERATIONS & ADDITION	IS	
STATUS: DA ISSUE	CHEET.	2 OF 18
LOT No: 88 DP No: 811825	SHEET:	2 01 10
STREET: 20 CARRABEEN DRIVE, OLD	BAR 243	0
CLIENT: BROOKHOUSE		


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430	START DATE:	03.12.2024	04.04.25	CC PLANS	н	MS
	_		28.04.25	PLAN RFI/ENERGY	J	MS
	DWG No:	A6058	06.05.25	BATHROOM LIPDATE/DECK NOTES	K	lms



PROPOSED ROOF AREA	AS .
NAME	AREA
CARPORT FLYOVER ROOF (PROPOSED)	68.3 m²
DECK FLYOVER ROOF (PROPOSED)	70.5 m²
DWELLING ROOF (EXISTING)	155.4 m²
FOYER ROOF (PROPOSED)	7.4 m²
LAUNDRY ROOF (PROPOSED)	9.2 m²
TOTAL	310.8 m²





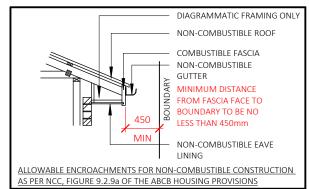

S68 & S138 INFO & LEGEND STORMWATER/RAINWATER TO BE CONNECTED TO EXISTING STORMWATER CONNECTION SURFACE AND SUB-SURFACE STORMWATER TO BE DISPOSED OF VIA PIPEWORK IN ACCORDANCE WITH AS 3500) WATER FLOW FROM RAINWATER STORAGE TANKS TO SILTATION CONTROL IN ACCORDANCE WITH COUNCIL GARDEN TAP LOCATIONS (TO BE USED AS A GUIDE ONLY) GTAP ⊬ APPLIANCES AND FIXTURES (TO BE USED AS A GUIDE ONLY) POLICY E1 AND THE ADOPTED AUSPEC STANDARD WATER FLOW FROM DOWNPIPES TO RAINWATER TANKS (TO SEWER LINE (TO BE USED AS A GUIDE ONLY) DOWNPIPE LOCATIONS (TO BE USED AS A GUIDE ONLY) DPO BE USED AS A GUIDE ONLY) ALL LEVELS ARE TO INDICATIVE AND NOT TO AHD. ALL LEVELS AND STORMWATER FLOW (TO BE USED AS A GUIDE ONLY) CONTOURS ARE TO BE CONFIRMED BY BUILDER / SURVEYOR PRIOR TO START OF CONSTRUCTION.

BAL - 12.5

BUSHFIRE NOTES: PLEASE REFER TO BUSHFIRE SELF ASSESSMENT KIT BY CLIENT/OWNER & TO BE CONSTRUCTED IN ACCORDANCE WITH AS 3959-2018: CONSTRUCTION OF BUILDINGS IN BUSHFIRE PRONE AREAS

BASIX NOTES:

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Designer prior to commencement of work.

commencement of shop drawings or fabrication Discrepancies to be referred to the consultant

PROJECT: ALTERATIONS & ADDITIONS STATUS: DA ISSUE LOT No: 88 **DP No:** 811825 STREET: 20 CARRABEEN DRIVE, OLD BAR 2430

CLIENT: BROOKHOUSE

SHEET: 3 OF 18

S68 & S138 PLAN SCALE: As indicated SHEET SIZE: Α3 START DATE: 03.12.2024 DWG No: A6058


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DRAWING REVISION + NOTES Issue: Drawn: Date: Revision: 17.02.25 REVISED 18.02.25 REVISED ΙAΕ 24.02.25 REVISED ΑE 04.04.25 CC PLANS MS PLAN RFI/ENERGY 28.04.25 MS BATHROOM UPDATE/DECK NOTES


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	EXTERNAL FINISHES
LABEL	MATERIAL DESCRIPTION
FBW	SELECT FACE BRICKWORK
GUT(A)	CLIP-SNAP CONTINUOUS OVERFLOW EAVES
	GUTTER SYSTEM TO COMPLY WITH AS 3500.3
LIN(A)	SCYON LINEA 150mm WIDE HORIZONTAL
	CLADDING
RFC	RENDERED FC SHEET
VCC	VERSICLAD CORROLINK (LIGHT)
VSM	VERSICLAD SPACEMAKER (LIGHT)

	COLUMN SCHEDULE
LABEL	COLUMN TYPE
COL. 1	140 x 140mm HARDWOOD POST ON STIRRUP
COL. 2	90 x 90mm HARDWOOD POST ON STIRRUP
COL 3	ROOF EXTENDA BRACKET OR SIMILAR



ALL TIMBER DECKS, STAIRS AND EXTERNAL TIMBER COLUMNS ARE TO BE CONSTRUCTED FROM BUSHFIRE RESISTING TIMBER SPECIES AS PER AS3959, APPENDIX F

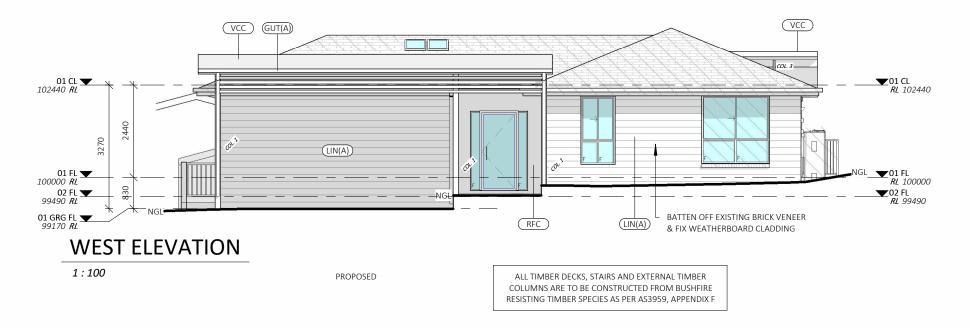

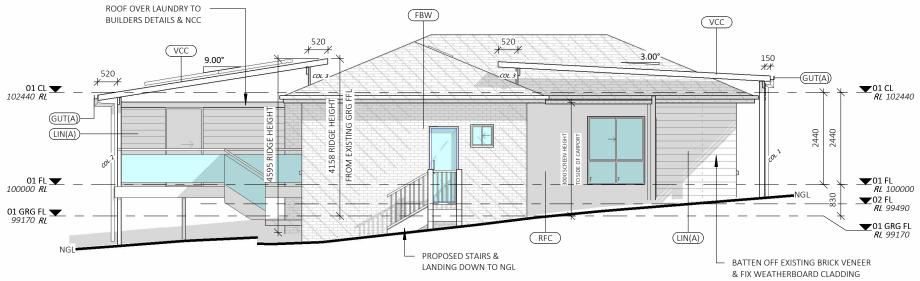NORTH ELEVATION

1:100

GLAZING SPECIFICATIONS:

WINDOWS AND DOORS SPECIFIED USE NFRC UW & SHGCW VALUES, WINDOWS AND DOORS AS SPECIFIED OR EQUIVALENT MUST BE INSTALLED ON SITE

LOW-E GLAZING: SINGLE LOW-E WITH STANDARD ALUMINIUM FRAMES TO D02_BED2, W06_BED2, W01_STUDY

STANDARD GLAZING: SINGLE CLEAR GLAZING WITH STANDARD ALUMINIUM FRAMES TO REMAINDER NEW

WEATHER STRIPPING TO BE INSTALLED THROUGHOUT.

PLEASE NOTE: ALL GLAZING IN BATHROOMS, ENSUITES, SPA ROOMS OR THE LIKE TO COMPLY WITH THE NCC, VO 2, H1D8 AND PART 8.4.6 OF ABCB HOUSING PROVISIONS

WINDOWS AND GLAZING TO COMPLY WITH:

AS 4055: WIND LOADS FOR HOUSING

AS 1288: GLASS IN BUILDINGS - SELECTION & INSTALLATION AS 2047: WINDOWS & EXTERNAL DOORS IN BUILDING AS 1170-Part 2: WIND ACTIONS

AS 3959: CONSTRUCTION OF BUILDINGS IN BUSHFIRE

PRONE AREAS *THE STANDARDS REFERRED ABOVE ARE THE VERSION ADOPTED BY THE NCC AT THE TIME THE RELEVANT

CONSTRUCTION CERTIFICATE OR COMPLYING DEVELOPMENT TERTIFICATE ARPLICATION IS PARTS 11.3.3, 11.3.4, 11.3.5 AND 11.3.6 OF THE ABCB

BUSHFIRE NOTES:

BAL - 12.5

PLEASE REFER TO BUSHFIRE SELF ASSESSMENT KIT BY CLIENT/OWNER & TO BE CONSTRUCTED IN ACCORDANCE WITH AS 3959-2018: CONSTRUCTION OF BUILDINGS IN BUSHFIRE PRONE AREAS

BASIX NOTES:

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GENERAL PLAN SET NOTES:

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PROJECT: ALTERATIONS & ADDITION	IS	
STATUS: DA ISSUE	CHEET.	7 OF 18
OT No: 88 DP No: 811825	SHEET:	/ UF 16
STREET: 20 CARRABEEN DRIVE, OLD	BAR 243	0

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DWG No:	A COE 0	28.04.25	PI
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T: 02 6583 4411			

STAIRS, HANDRAILS & BALUSTRADE NOTES:

STAIRS TO COMPLY WITH NCC VOL. 2, H5D2, H5D3 AND

BARRIERS AND HANDRAILS TO BE NO LESS THAN 1000mm

FROM PROPOSED FINISHED FL. BALUSTRADE & HANDRAIL

TO BE IN ACCORDANCE WITH NCC, VOL. 2, H5D3 AND

PART 11.2.1 AND 11.2.2 OF THE ABCB HOUSING

ELEVATIONS

PROVISIONS.

DRAWING REVISION + NOTES Revision: Issue: Drawn: REVISED REVISED ΙAΕ REVISED ΑE MS CC PLANS PLAN RFI/ENERGY MS SATHROOM UPDATE/DECK NOTES

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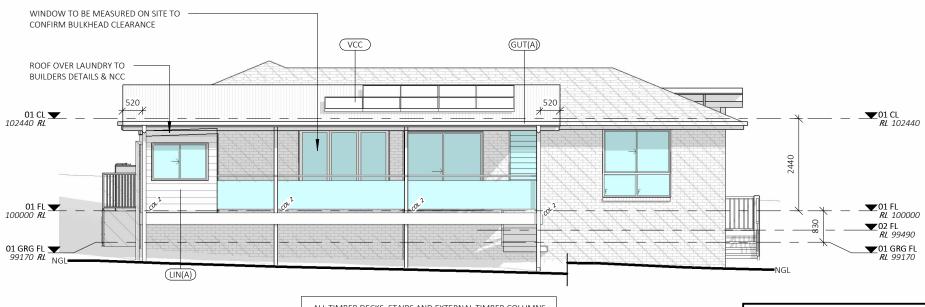
	EXTERNAL FINISHES
LABEL	MATERIAL DESCRIPTION
FBW	SELECT FACE BRICKWORK
GUT(A)	CLIP-SNAP CONTINUOUS OVERFLOW EAVES
	GUTTER SYSTEM TO COMPLY WITH AS 3500.3
LIN(A)	SCYON LINEA 150mm WIDE HORIZONTAL
	CLADDING
RFC	RENDERED FC SHEET
VCC	VERSICLAD CORROLINK (LIGHT)
VSM	VERSICLAD SPACEMAKER (LIGHT)

	COLUMN SCHEDULE
LABEL	COLUMN TYPE
COL. 1	140 x 140mm HARDWOOD POST ON STIRRUP
COL. 2	90 x 90mm HARDWOOD POST ON STIRRUP
COL. 3	ROOF EXTENDA BRACKET OR SIMILAR



SOUTH ELEVATION

1:100



EAST ELEVATION

1:100

ALL TIMBER DECKS, STAIRS AND EXTERNAL TIMBER COLUMNS ARE TO BE CONSTRUCTED FROM BUSHFIRE RESISTING TIMBER SPECIES AS PER AS3959, APPENDIX F

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BAL - 12.5

BUSHFIRE NOTES: PLEASE REFER TO BUSHFIRE SELF ASSESSMENT KIT BY CLIENT/OWNER & TO BE CONSTRUCTED IN ACCORDANCE WITH AS 3959-2018: CONSTRUCTION OF BUILDINGS IN BUSHFIRE PRONE AREAS

BASIX NOTES:

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Building Designers

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PROJECT: ALTERATIONS & ADDITIONS STATUS: DA ISSUE SHEET: 8 OF 18 **DP No:** 811825 LOT No: 88 STREET: 20 CARRABEEN DRIVE, OLD BAR 2430 check all the dimensions on the job prior to ommencement of shop drawings or fabrication iscrepancies to be referred to the consultant **CLIENT:** BROOKHOUSE Designer prior to commencement of work.

Date: 17.02.25 SCALE: 1:100 18.02.25 SHEET SIZE: Α3 24.02.25 04.04.25 START DATE: 03.12.2024 28.04.25 DWG No: A6058 T: 02 6583 4413

STAIRS, HANDRAILS & BALUSTRADE NOTES:

STAIRS TO COMPLY WITH NCC VOL. 2, H5D2, H5D3 AND

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PART 11.2.1 AND 11.2.2 OF THE ABCB HOUSING

PROVISIONS.


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DRAWING REVISION + NOTES

EXTERNAL FINISHES					
LABEL	MATERIAL DESCRIPTION				
FBW	SELECT FACE BRICKWORK				
GUT(A)	CLIP-SNAP CONTINUOUS OVERFLOW EAVES GUTTER SYSTEM TO COMPLY WITH AS 3500.3				
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RFC	RENDERED FC SHEET				
VCC	VERSICLAD CORROLINK (LIGHT)				
VSM	VERSICLAD SPACEMAKER (LIGHT)				

PROPOSED ROOF AREAS				
NAME	AREA			
CARPORT FLYOVER ROOF (PROPOSED)	68.3 m²			
DECK FLYOVER ROOF (PROPOSED)	70.5 m ²			
OWELLING ROOF (EXISTING)	155.4 m²			
OYER ROOF (PROPOSED)	7.4 m²			
AUNDRY ROOF (PROPOSED)	9.2 m²			
OTAL	310.8 m ²			



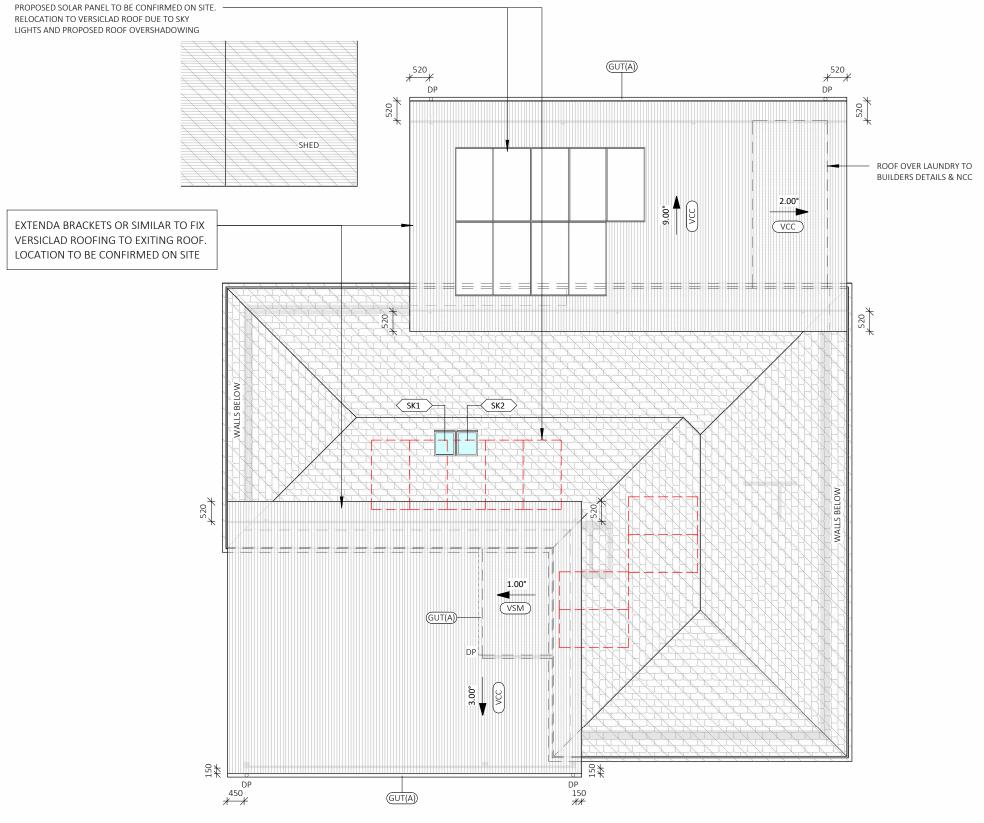

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BUSHFIRE NOTES:

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CONSTRUCTION OF BUILDINGS IN BUSHFIRE PRONE AREAS

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BAL - 12.5

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PROJECT:

ALTERATIONS & ADDITIONS

PROJECT:

STATUS: DA ISSUE

LOT No: 88 DP No: 811825

STREET: 20 CARRABEEN DRIVE, OLD BAR 2430

CLIENT: BROOKHOUSE

SCALE: 1:100 17.02.25 18.02.25 SHEET SIZE: A3 24.02.25 START DATE: 03.12.2024 04.04.25 DWG No: A6058 06.05.25

ROOF PLAN

T: 02 6583 4411

 DRAWING REVISION + NOTES

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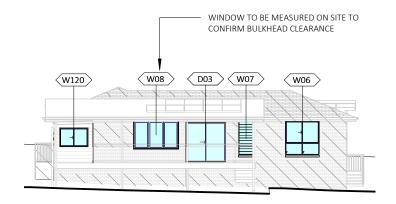
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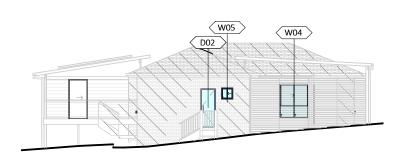
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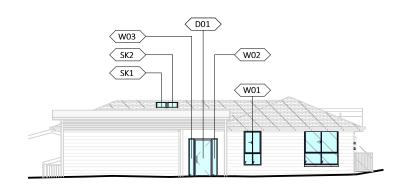
EAST FACE GLAZING

1:200




NORTH FACE GLAZING

1:200



WEST FACE GLAZING

1:200

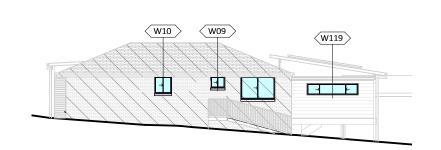

SOUTH FACE GLAZING

1:200

WINDOW GLAZING SCHEDULE							
NUMBER	ROOM	HEIGHT	WIDTH	TYPE	CONSTRUCTION	GLAZING	AREA
SK1	KITCHEN	700	550	SKYLIGHT	ALUMINIUM	STANDARD	0.39 m ²
SK2	KITCHEN	700	550	SKYLIGHT	ALUMINIUM	STANDARD	0.39 m ²
W01	STUDY	1800	910	SLIDING	ALUMINIUM	LOW-E	1.64 m²
W02	FOYER	2100	300	FIXED GLASS	ALUMINIUM	STANDARD	0.63 m ²
W03	FOYER	2100	300	FIXED GLASS	ALUMINIUM	STANDARD	0.63 m ²
W04	FOYER	1800	1510	SLIDING	ALUMINIUM	STANDARD	2.72 m²
W05	ENS (2)	600	610	SLIDING	ALUMINIUM	STANDARD	0.37 m ²
W06	BED 2	1800	1800	SLIDING	ALUMINIUM	LOW-E	3.24 m²
W07	KITCHEN	1800	800	LOUVRE	ALUMINIUM	STANDARD	1.44 m²
W08	MEALS/LIVING	1500	2400	BI-FOLD	ALUMINIUM	STANDARD	3.60 m ²
W09	BATHRM	600	770	SLIDING	ALUMINIUM	STANDARD	0.46 m ²
W10	ENS (1)	900	910	SLIDING	ALUMINIUM	STANDARD	0.82 m ²
W119	LDRY	600	2710	SLIDING	ALUMINIUM	STANDARD	1.63 m²
W120	LDRY	1000	1510	SLIDING	ALUMINIUM	STANDARD	1.51 m ²

DOOR GLAZING SCHEDULE							
NUMBER	ROOM	HEIGHT	WIDTH	TYPE	CONSTRUCTION	GLAZING	AREA
D01	FOYER	2050	920	HINGED	ALUMINIUM	STANDARD	1.89 m²
D02	BED 2	2050	770	HINGED	ALUMINIUM	LOW-E	1.58 m²
D03	MEALS/LIVING	2100	2110	SLIDING DOOR	ALUMINIUM	STANDARD	4.43 m ²

7.90 m²

19.45 m²

GLAZING SPECIFICATIONS:

WINDOWS AND DOORS SPECIFIED USE NFRC UW & SHGCW VALUES WINDOWS AND DOORS AS SPECIFIED OR **EQUIVALENT MUST BE INSTALLED ON SITE**

LOW-E GLAZING: SINGLE LOW-E WITH STANDARD ALUMINIUM FRAMES TO D02_BED2, W06_BED2, W01 STUDY

STANDARD GLAZING: SINGLE CLEAR GLAZING WITH STANDARD ALUMINIUM FRAMES TO REMAINDER NEW

WEATHER STRIPPING TO BE INSTALLED THROUGHOUT.

PLEASE NOTE: ALL GLAZING IN BATHROOMS, ENSUITES, 2, H1D8 AND PART 8.4.6 OF ABCB HOUSING PROVISIONS

WINDOWS AND GLAZING TO COMPLY WITH:

AS 4055 : WIND LOADS FOR HOUSING

AS 1288: GLASS IN BUILDINGS - SELECTION & INSTALLATION AS 2047: WINDOWS & EXTERNAL DOORS IN BUILDING

AS 1170-Part 2: WIND ACTIONS AS 3959: CONSTRUCTION OF BUILDINGS IN BUSHFIRE PRONE AREAS

*THE STANDARDS REFERRED ABOVE ARE THE VERSION ADOPTED BY THE NCC AT THE TIME THE RELEVANT

AE

ΑE

MS

MS

CONSTRUCTION CERTIFICATE OR COMPLYING
DEVELOPMENT DENTIFICATE ARCICATION IS MACE

BUSHFIRE NOTES:

BAL - 12.5

PLEASE REFER TO BUSHFIRE SELF ASSESSMENT KIT BY CLIENT/OWNER & TO BE CONSTRUCTED IN ACCORDANCE WITH AS 3959-2018: CONSTRUCTION OF BUILDINGS IN BUSHFIRE PRONE AREAS

BASIX NOTES:

PLEASE REFER TO THE "SUMMARY OF BASIX COMMITMENTS" ON PAGE 3 FOR FURTHER INFORMATION. PLEASE REFER TO THE BASIX CERTIFICATE FOR EXACT DETAILS

GENERAL PLAN SET NOTES:

CHECK ALL DIMENSIONS ON SITE. THIS DRAWING IS TO BE READ IN CONJUNCTION WITH ALL RELEVANT CONTRACTS. SPECIFICATIONS. REPORTS, DRAWINGS, LEGENDS, NATIONAL CONSTRUCTION CODE, AUS &



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PROJECT: ALTERATIONS & ADDITIONS					
STATUS: DA ISSUE	SHEET: 11 OF 18				
OT No: 88 DP No: 811825	SHEET: 11 OF 16				
STREET: 20 CARRABEEN DRIVE, OLD BAR 2430					

GLAZING		
		Date:
SCALE:	As indicated	17.02.25
		18.02.25
SHEET SIZE:	A3	24.02.25
START DATE:	03.12.2024	04.04.25
DWG No:	A COE O	28.04.25

NZ STANDARDS, ENGINEERING & COUNCIL APPROVALS DRAWING REVISION + NOTES Issue: Drawn: Revision:

REVISED

REVISED

REVISED


CC PLANS

PLAN RFI/ENERGY

CLIENT: BROOKHOUSE Designer prior to commencement of work. BATHROOM UPDATE/DECK NOTES 89A Lord Street (PO Box 5667), Port Macquarie nsw 2444 | Shop 17 Centrepoint Arcade, Taree NSW 2430 WWW. COLLINSWCOLLINS.COM.AU T: 02 6583 4413



PERSPECTIVE 1

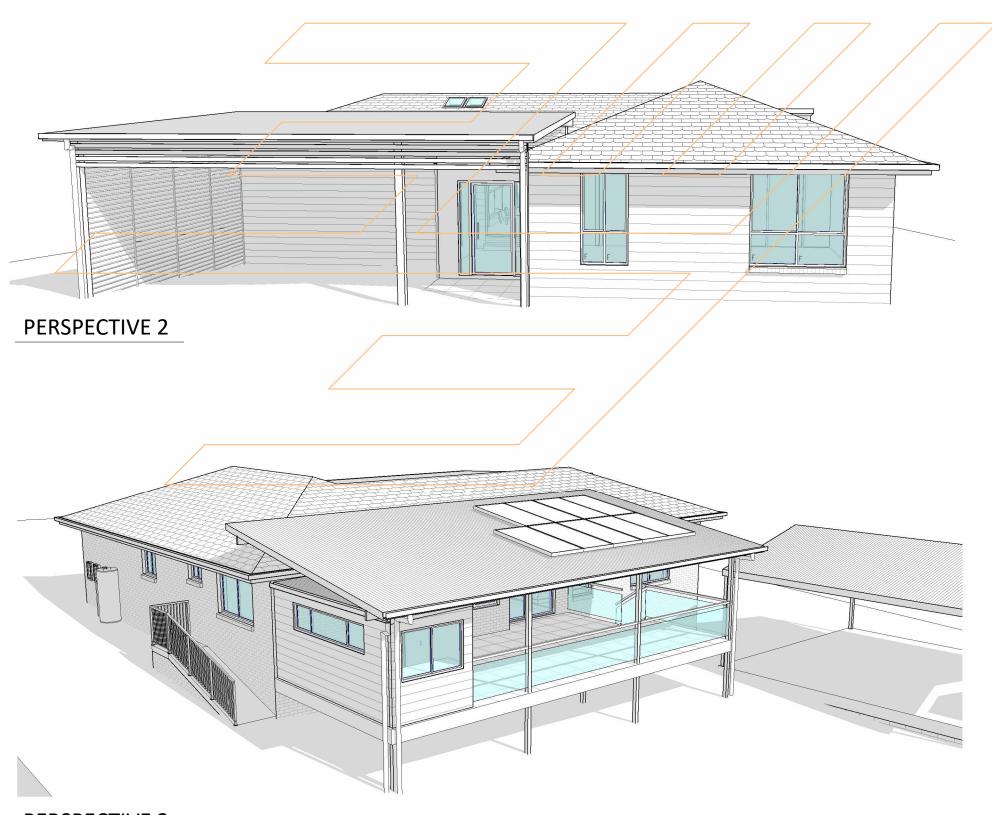

PERSPECTIVE 3

DA ISSUE ONLY

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BAL - 12.5

BUSHFIRE NOTES:

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BASIX NOTES:

CLIENT: BROOKHOUSE

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PROJECT: ALTERATIONS & ADDITIONS STATUS: DA ISSUE SHEET: 12 OF 18 LOT No: 88 DP No: 811825 STREET: 20 CARRABEEN DRIVE, OLD BAR 2430

17.02.25 SCALE: REVISED 18.02.25 REVISED SHEET SIZE: А3 24.02.25 REVISED START DATE: 03.12.2024 04.04.25 CC PLANS 28.04.25 DWG No: A6058 BATHROOM UPDATE/DECK NOTES

PERSPECTIVE VIEWS

T: 02 6583 4411

Date: Revision: Issue: Drawn: AE AE MS PLAN RFI/ENERGY MS

DRAWING REVISION + NOTES